



01- LOCATION MAP
SCALE: NTS

PROJECT DESCRIPTION

The construction is the renovation of a +/- 7400 sq feet existing warehouse for the office and warehouse of [REDACTED].


We are adding partition walls inside the existing warehouse. The partitions are not structural. There is no change on the existing structure, existing concrete floor, existing facade and existing plumbing system.

Smoke alarm and carbon monoxide alarms to be installed in the office space, kitchen, conference room, storage rooms. (See electrical plans)


Partition walls to be 2x4 metal studs (non structural)
Provide wood framing for doors and windows.

Notes:
- All dimensions to be verified .
- Verify skylights positions and dimensions.
- Verify existing structure.


DOCUMENT INDEX		
DWG NO	DWG TITLE	ISSUE DATE
A-1	SITE PLAN, LOCATION MAP, AND DESCRIPTION	03.05.15
A-2	FLOOR PLAN 1/2, LONGITUDINAL SECTION AND ELEVATIONS	03.05.15
A-3	PARTITION TYPE, DETAIL, WINDOWS, TRANSVERSE SECTION AND DETAILED FLOOR PLAN 1/4	03.05.15

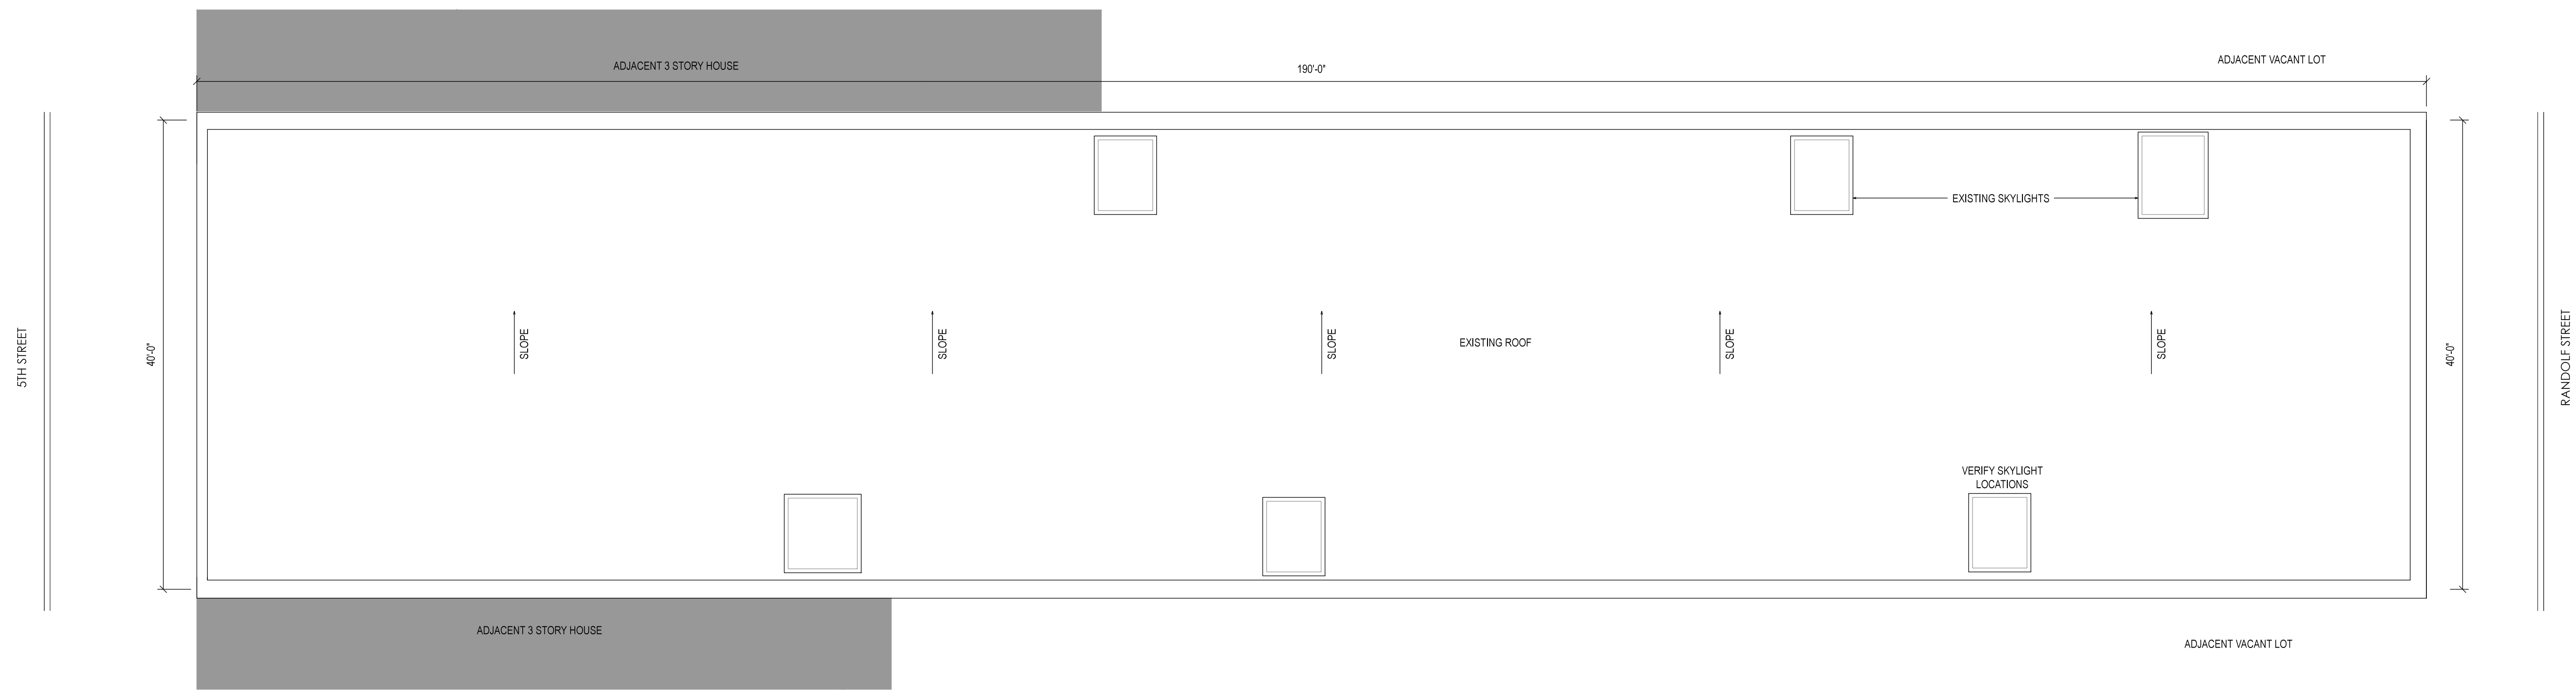


02- SITE PLAN / ROOF PLAN
SCALE: 1/8" = 1'-0"

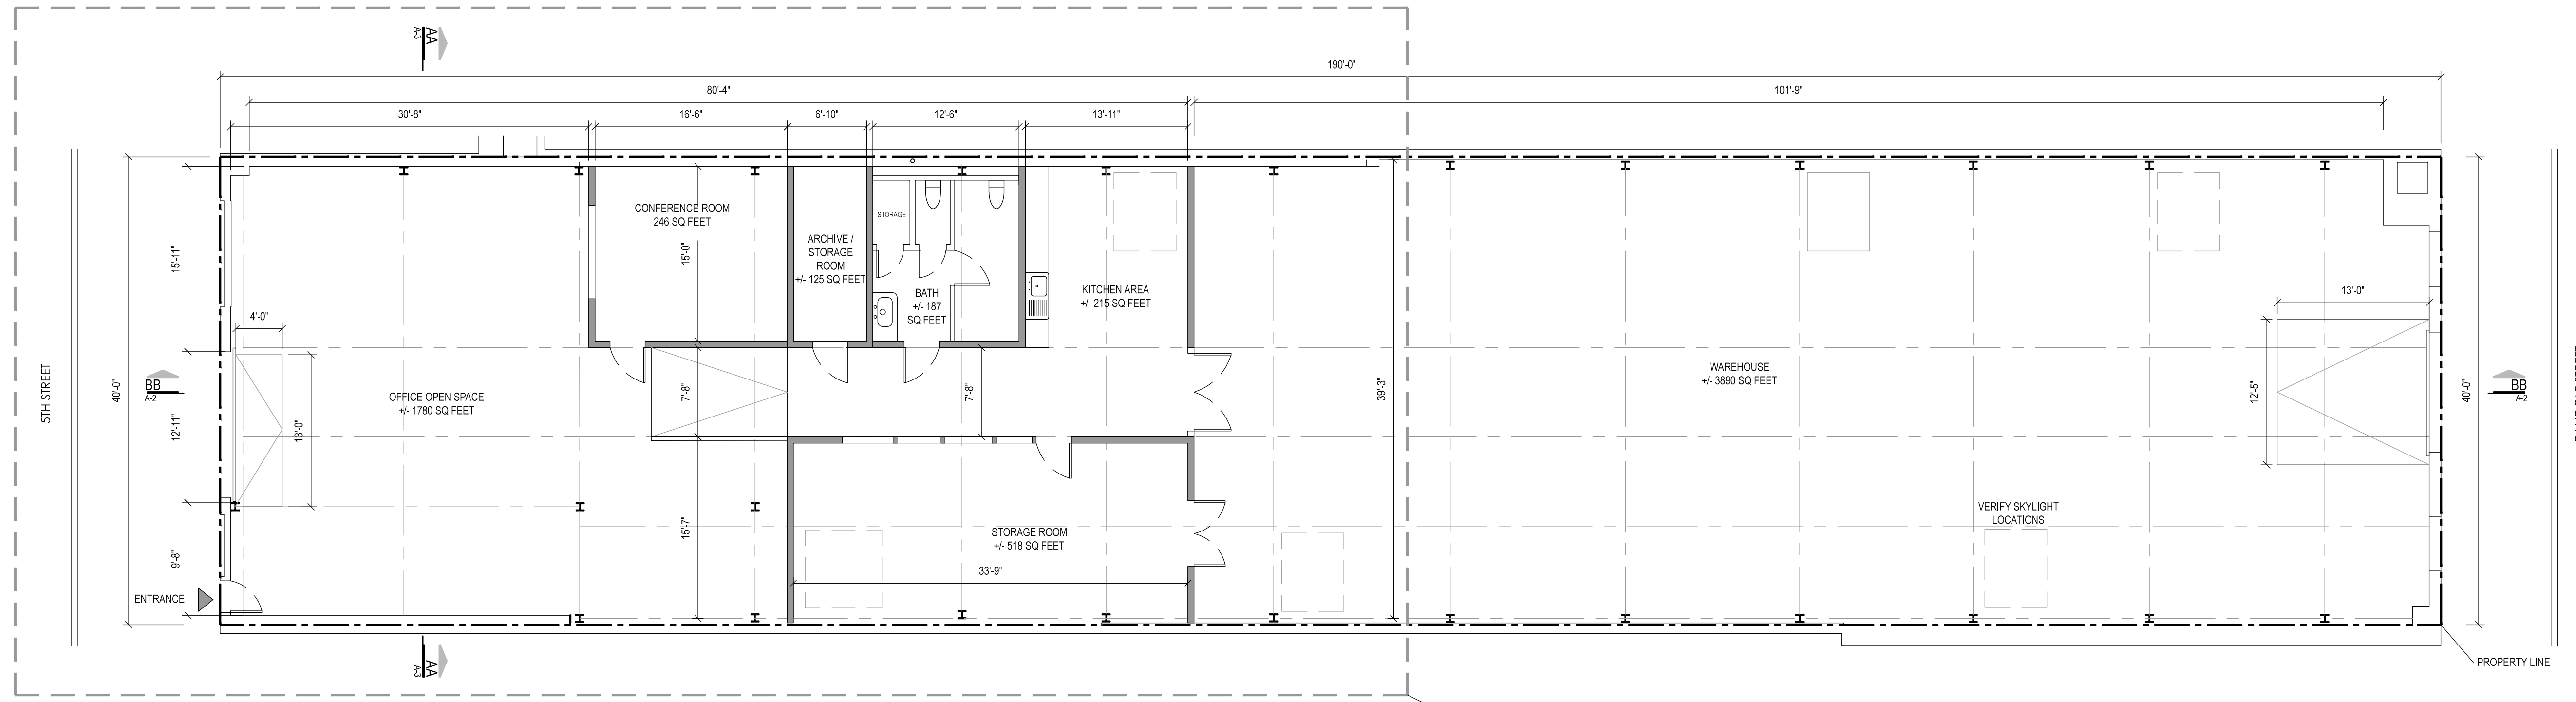


01- FLOOR PLAN - REFERENCE PLAN
SCALE: 1/8" = 1'-0"

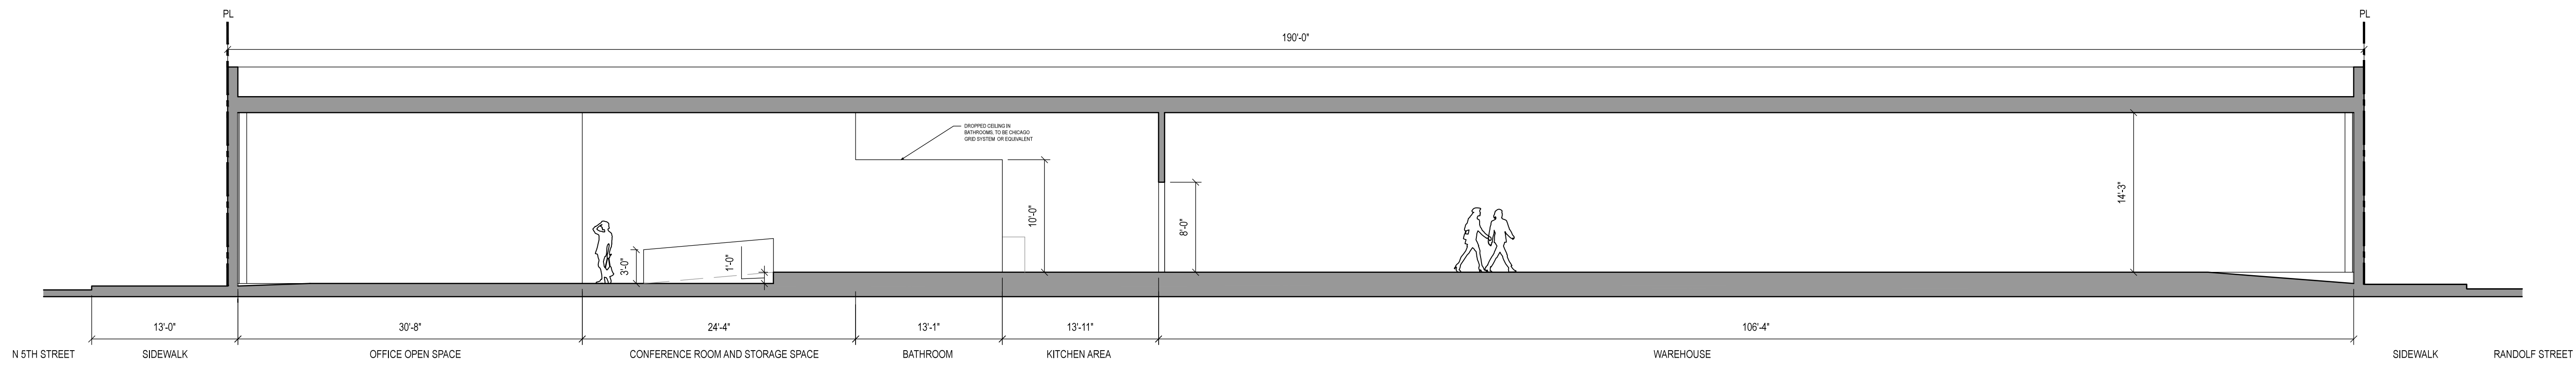


02 - BB / LONGITUDINAL SECTION
SCALE: 1/8" = 1'-0"

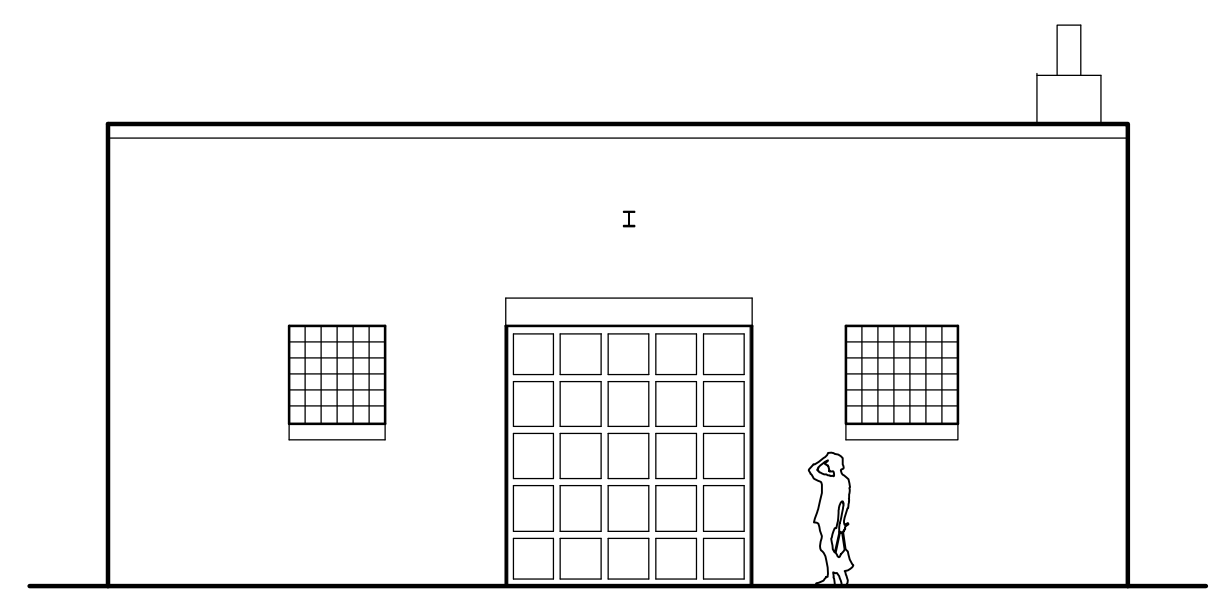


03- ELEVATION RANDOLF STREET
SCALE: 1/8" = 1'-0"

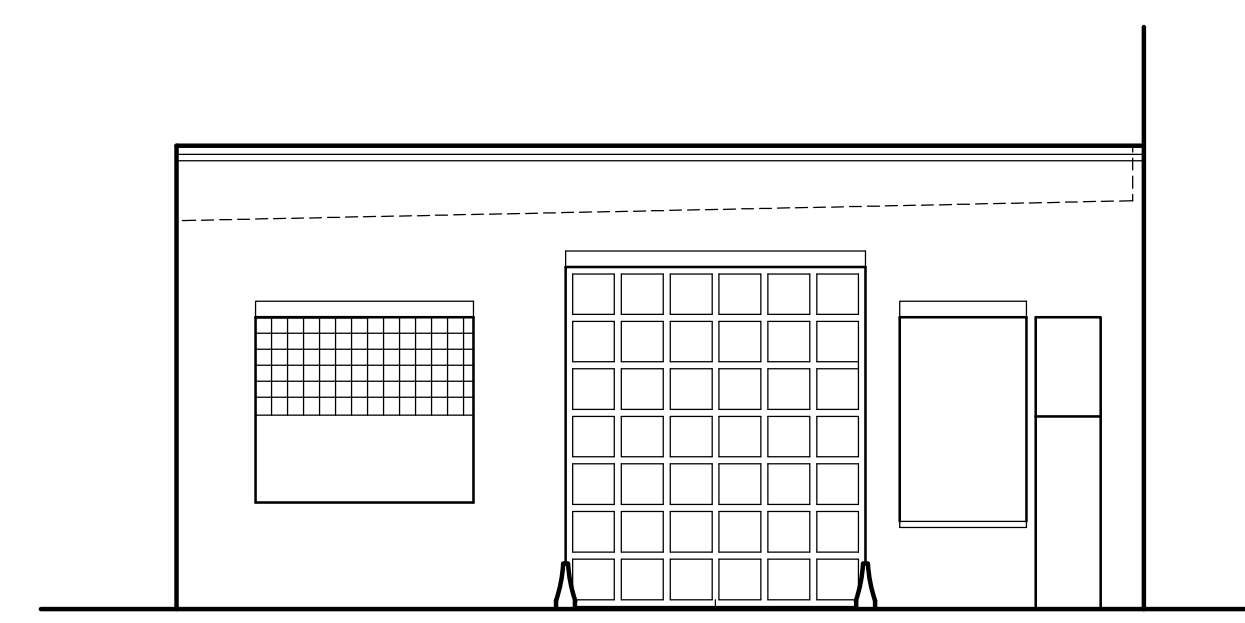


04- ELEVATION 5TH STREET
SCALE: 1/8" = 1'-0"

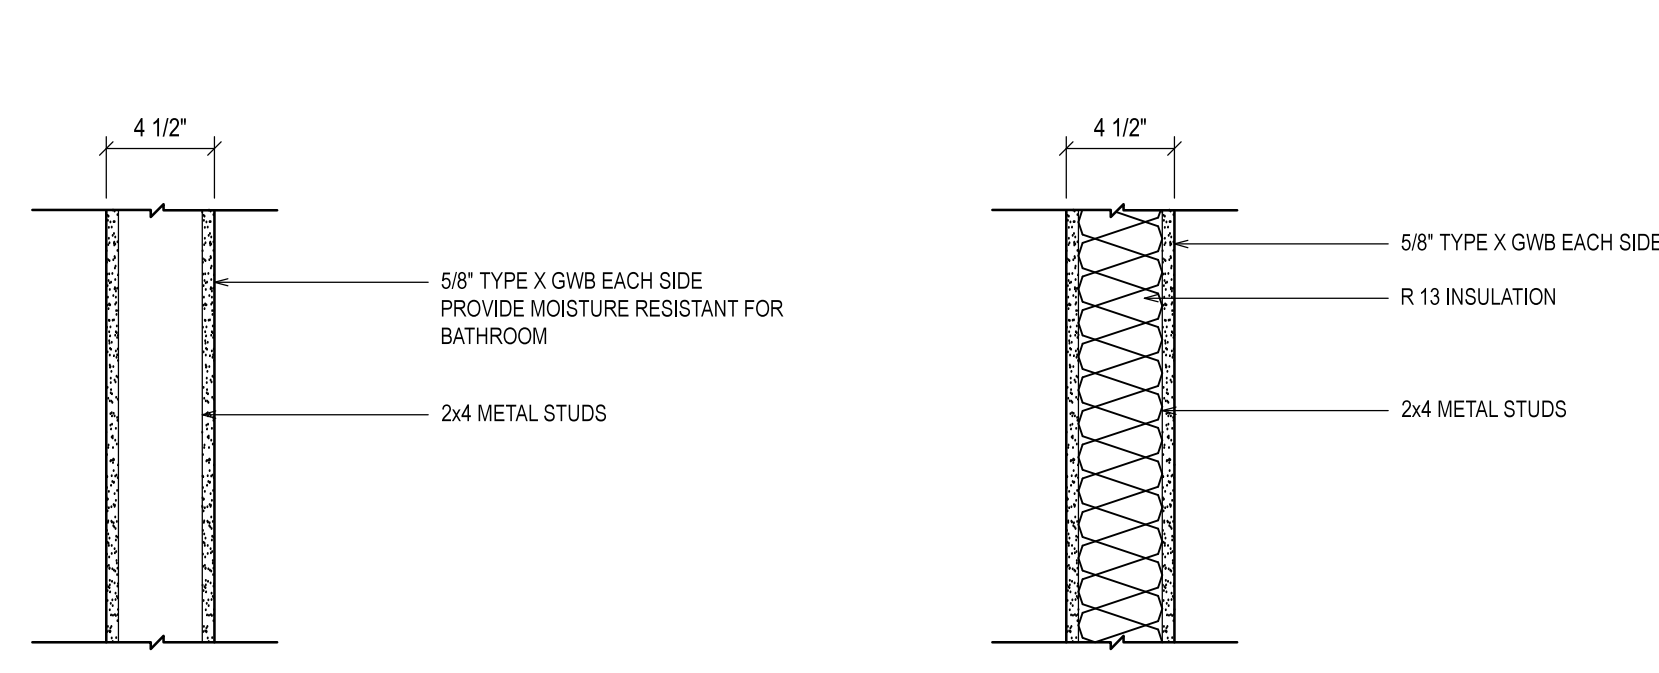



01- PARTITION TYPE 1
SCALE: 1/2" = 1'-0"

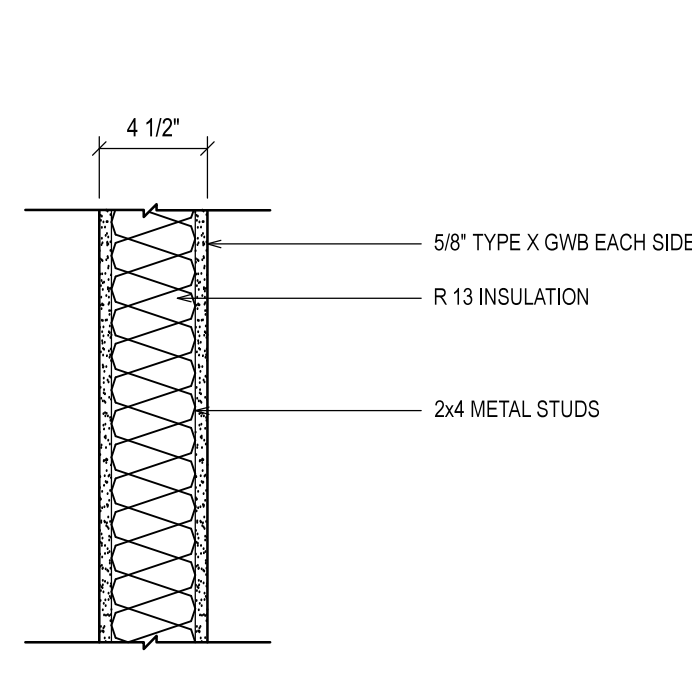


02- PARTITION TYPE 2
SCALE: 1/2" = 1'-0"

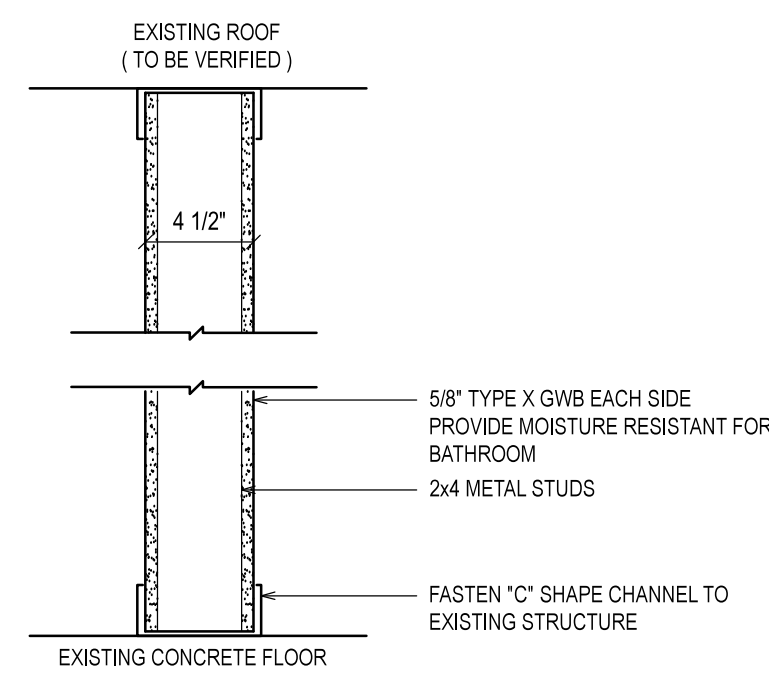


03 - DETAIL PARTITION WALL (NON BEARING)
@ EXISTING STRUCTURE
SCALE: 1/2" = 1'-0"

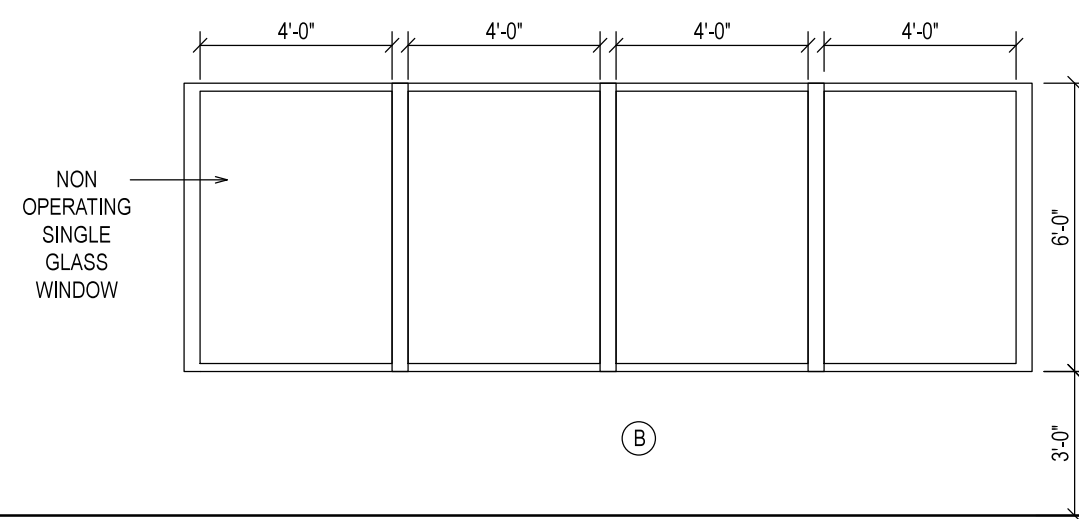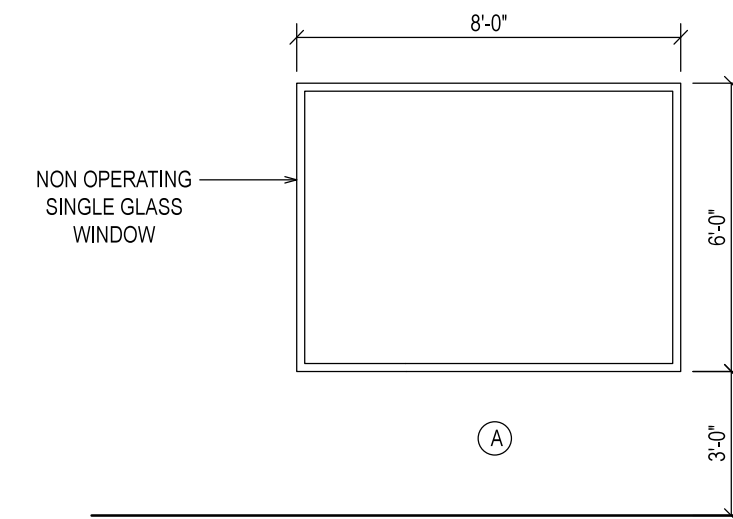

04 - INTERIOR WINDOW TYPE
SCALE: 1/2" = 1'-0"

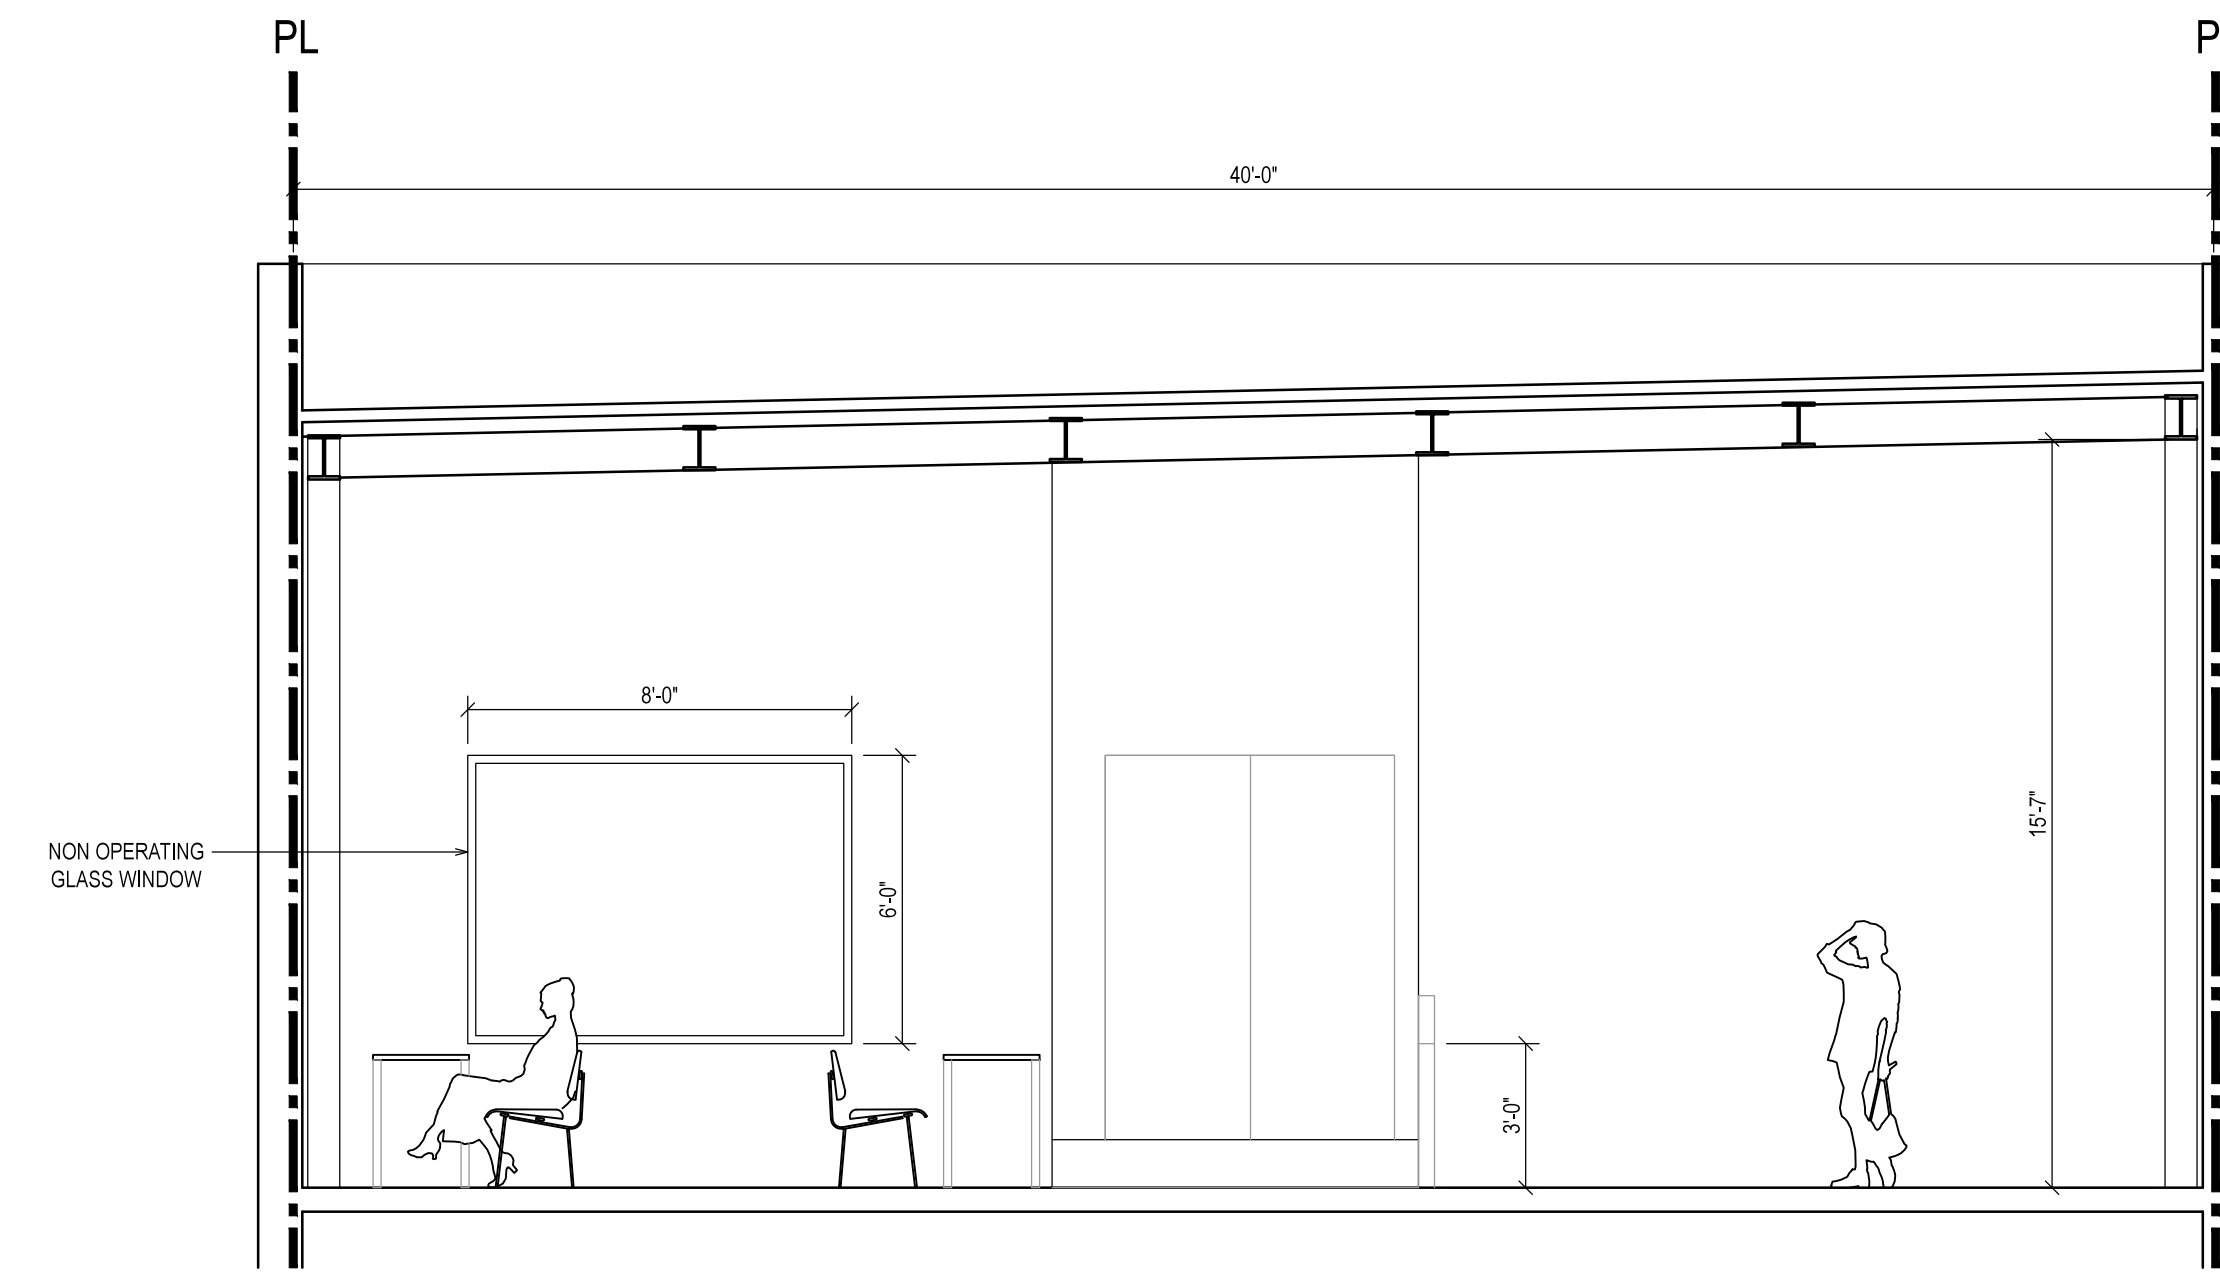

05 - AA TRANSVERSE SECTION
SCALE: 1/4" = 1'-0"

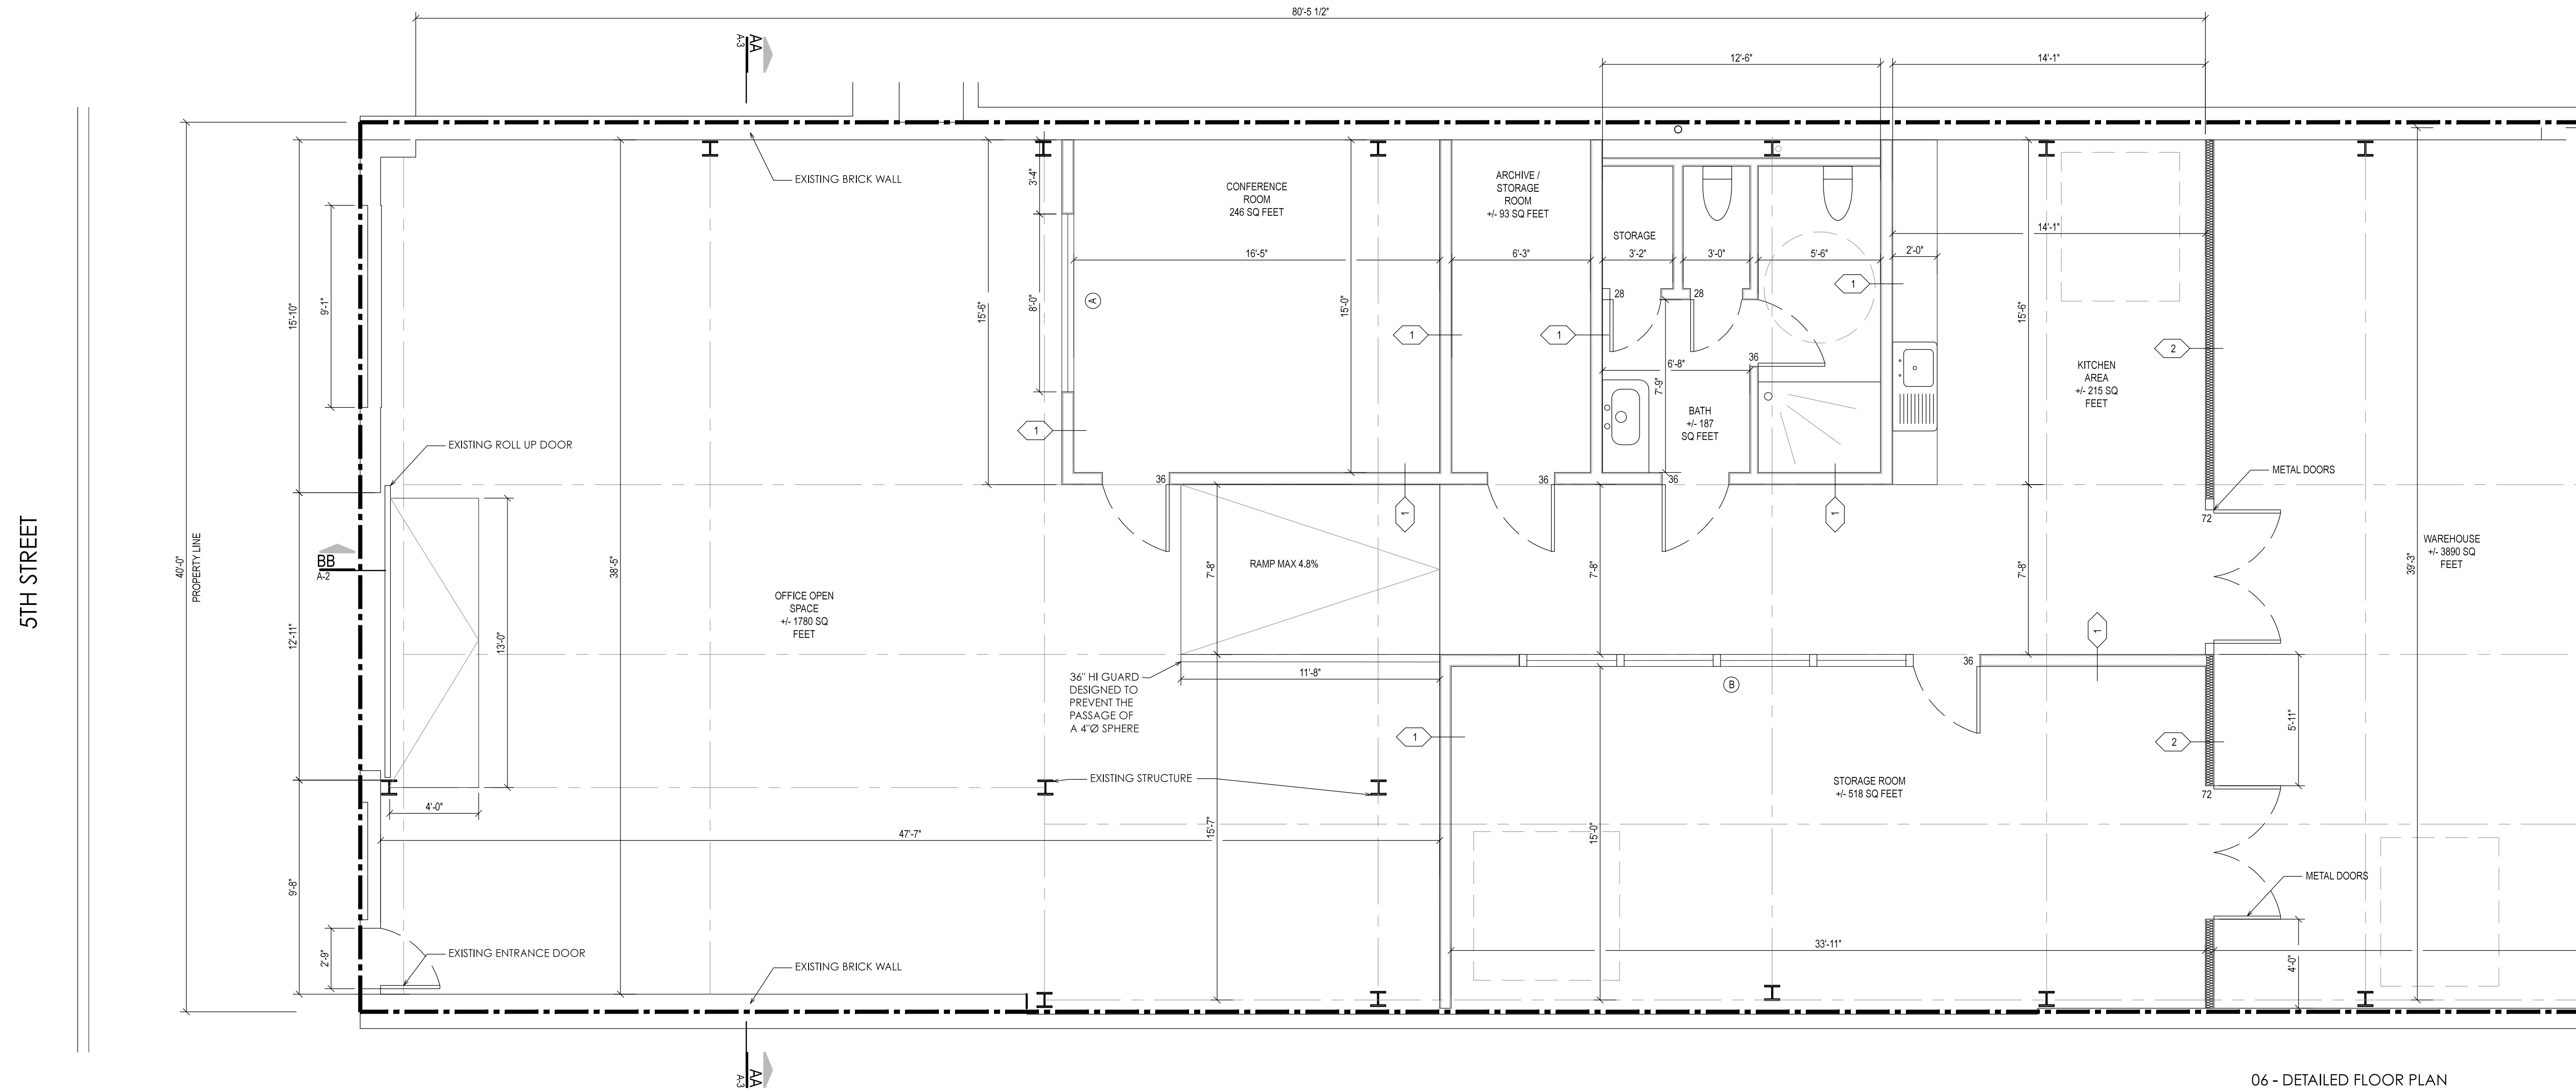

06 - DETAILED FLOOR PLAN
SCALE: 1/4" = 1'-0"

5TH STREET